
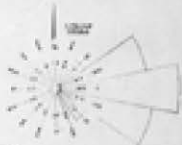
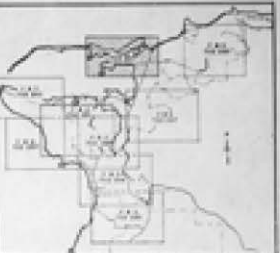


"FOR OFFICIAL USE ONLY"

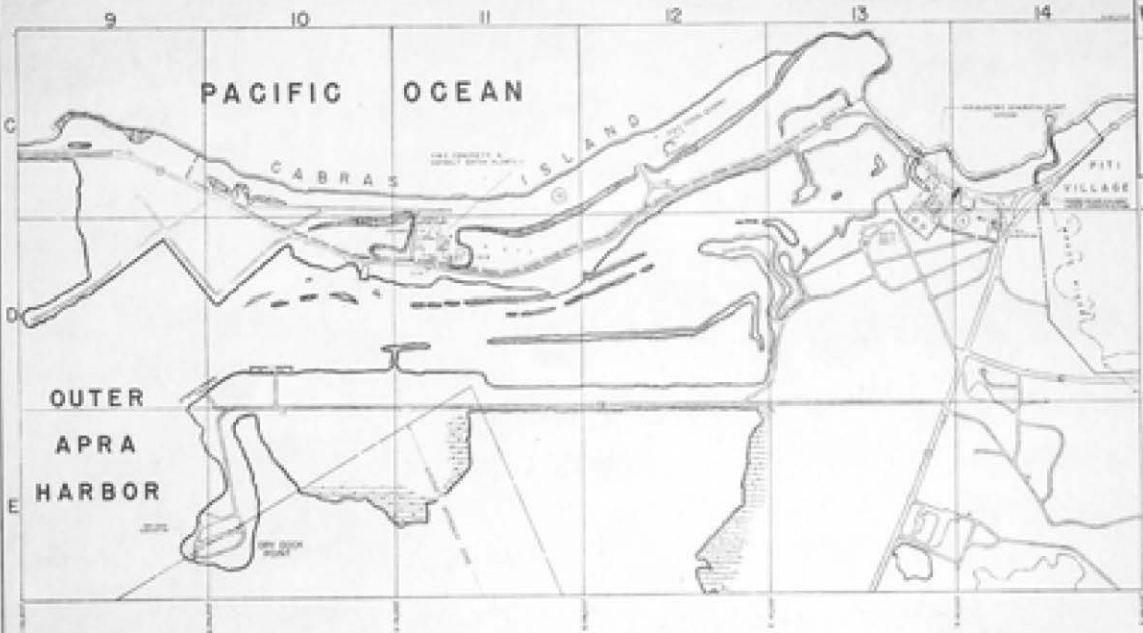

"Scale of Variation to True North"

- LEGEND**
- BOUNDARY OF WATERSHED
  - BOUNDARY OF DISTRICT
  - BOUNDARY OF TOWN
  - BOUNDARY OF VILLAGE
  - ROAD
  - RAILROAD
  - RAILROAD UNDER CONSTRUCTION
  - RAILROAD PLANNED
  - RAILROAD ABANDONED
  - RAILROAD TO BE ABANDONED
  - RAILROAD TO BE RECONSTRUCTED
  - RAILROAD TO BE EXTENDED
  - RAILROAD TO BE EXTENDED AND RECONSTRUCTED
  - RAILROAD TO BE EXTENDED AND ABANDONED
  - RAILROAD TO BE EXTENDED AND RECONSTRUCTED AND ABANDONED
  - RAILROAD TO BE EXTENDED AND RECONSTRUCTED AND EXTENDED
  - RAILROAD TO BE EXTENDED AND RECONSTRUCTED AND EXTENDED AND ABANDONED
  - RAILROAD TO BE EXTENDED AND RECONSTRUCTED AND EXTENDED AND RECONSTRUCTED
  - RAILROAD TO BE EXTENDED AND RECONSTRUCTED AND EXTENDED AND RECONSTRUCTED AND EXTENDED
  - RAILROAD TO BE EXTENDED AND RECONSTRUCTED AND EXTENDED AND RECONSTRUCTED AND EXTENDED AND ABANDONED
  - RAILROAD TO BE EXTENDED AND RECONSTRUCTED AND EXTENDED AND RECONSTRUCTED AND EXTENDED AND RECONSTRUCTED AND EXTENDED AND ABANDONED


NO. 1	PROPOSED
NO. 2	EXISTING
NO. 3	ABANDONED
NO. 4	TO BE ABANDONED
NO. 5	TO BE RECONSTRUCTED
NO. 6	TO BE EXTENDED
NO. 7	TO BE EXTENDED AND RECONSTRUCTED
NO. 8	TO BE EXTENDED AND ABANDONED
NO. 9	TO BE EXTENDED AND RECONSTRUCTED AND ABANDONED
NO. 10	TO BE EXTENDED AND RECONSTRUCTED AND EXTENDED
NO. 11	TO BE EXTENDED AND RECONSTRUCTED AND EXTENDED AND ABANDONED
NO. 12	TO BE EXTENDED AND RECONSTRUCTED AND EXTENDED AND RECONSTRUCTED
NO. 13	TO BE EXTENDED AND RECONSTRUCTED AND EXTENDED AND RECONSTRUCTED AND EXTENDED
NO. 14	TO BE EXTENDED AND RECONSTRUCTED AND EXTENDED AND RECONSTRUCTED AND EXTENDED AND ABANDONED
NO. 15	TO BE EXTENDED AND RECONSTRUCTED AND EXTENDED AND RECONSTRUCTED AND EXTENDED AND RECONSTRUCTED AND EXTENDED

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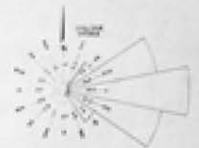


PROJECT NO.	NOV/0626
PROJECT NAME	PUBLIC WORKS CENTER - WASHINGTON
PROJECT LOCATION	WASHINGTON
PROJECT DATE	NOV 1966
PROJECT SCALE	1" = 100'
PROJECT DRAWN BY	W. J. HAYES
PROJECT CHECKED BY	J. W. HAYES
PROJECT APPROVED BY	J. W. HAYES
PROJECT DATE	NOV 1966
PROJECT NO.	NOV/0626
PROJECT NAME	PUBLIC WORKS CENTER - WASHINGTON
PROJECT LOCATION	WASHINGTON
PROJECT DATE	NOV 1966
PROJECT SCALE	1" = 100'
PROJECT DRAWN BY	W. J. HAYES
PROJECT CHECKED BY	J. W. HAYES
PROJECT APPROVED BY	J. W. HAYES
PROJECT DATE	NOV 1966

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KEY MAP OF SHEETS

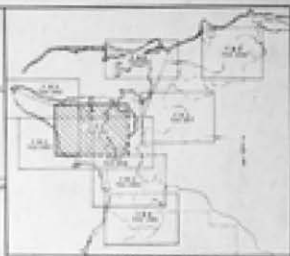

TRUE NORTH

INNER  
APRA  
HARBOR

LEGEND

EXISTING BUILDING	EXISTING ROAD	EXISTING UTILITY
PROPOSED BUILDING	PROPOSED ROAD	PROPOSED UTILITY
EXISTING WALL	EXISTING FENCE	EXISTING CURB
PROPOSED WALL	PROPOSED FENCE	PROPOSED CURB
EXISTING DRIVE	EXISTING SIDEWALK	EXISTING BIKEWAY
PROPOSED DRIVE	PROPOSED SIDEWALK	PROPOSED BIKEWAY
EXISTING PARKING	EXISTING PLANTING	EXISTING LANDSCAPE
PROPOSED PARKING	PROPOSED PLANTING	PROPOSED LANDSCAPE
EXISTING WATER	EXISTING DRAINAGE	EXISTING EROSION CONTROL
PROPOSED WATER	PROPOSED DRAINAGE	PROPOSED EROSION CONTROL

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AREA SUBJECT	AREA SUBJECT
1. BUILDING	2. ROAD
3. DRIVE	4. SIDEWALK
5. BIKEWAY	6. FENCE
7. CURB	8. WALL
9. UTILITY	10. PLANTING
11. LANDSCAPE	12. WATER
13. DRAINAGE	14. EROSION CONTROL



NO/D627



MASTER SHORE STATION  
DEVELOPMENT PLAN  
PART III - SECTION 2  
GENERAL DEVELOPMENT PLAN

DATE: 1968

SCALE: 1:500

PROJECT NO. 709.000

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KEY MAP OF SHEETS

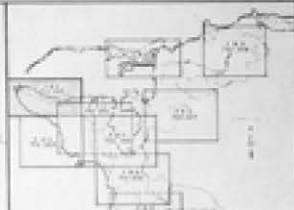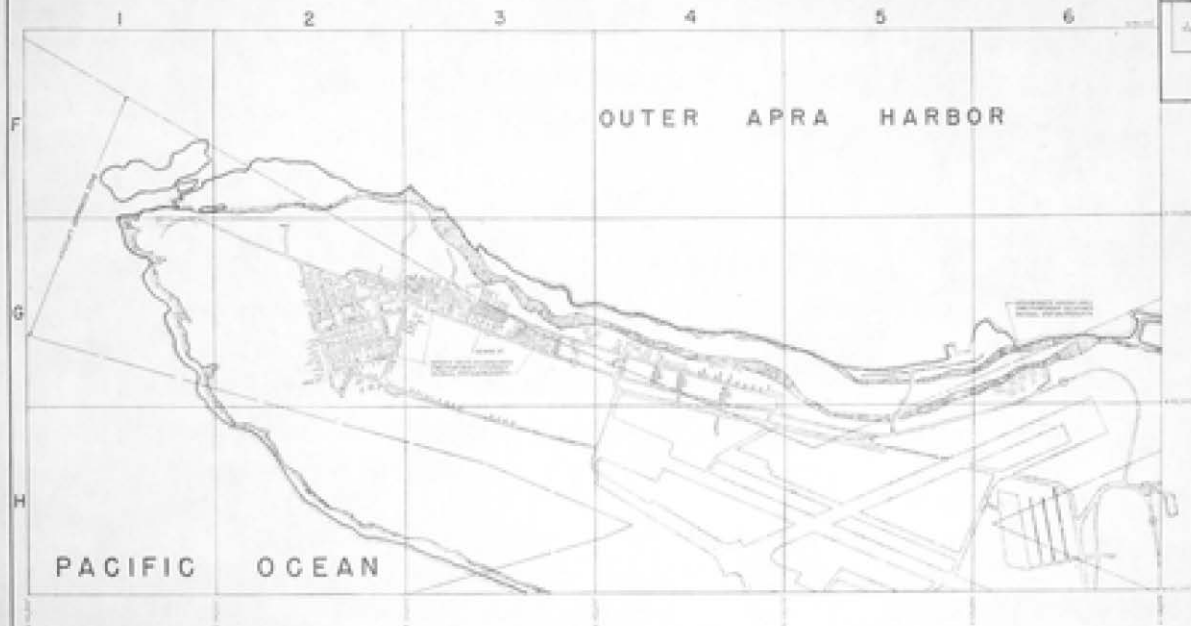

COMPASS ROSE

LEGEND

- UNDEVELOPED LAND
- ROADS
- RAILROADS
- SEWER
- WATER
- POWER
- TELEPHONE
- POSTAL
- RECREATION
- INDUSTRIAL
- RESIDENTIAL
- OFFICIAL
- UNDEVELOPED LAND
- RAILROADS
- SEWER
- WATER
- POWER
- TELEPHONE
- POSTAL
- RECREATION
- INDUSTRIAL
- RESIDENTIAL
- OFFICIAL

"FOR OFFICIAL USE ONLY"

PROJECT NO.	NS/0428
PROJECT NAME	MASTER SHORE STATION DEVELOPMENT PLAN
SECTION	PART 2 - SECTION 2
DATE	1962
SCALE	1" = 100'
DESIGNED BY	
DRAWN BY	
CHECKED BY	
APPROVED BY	
DATE	
SCALE	
DESIGNED BY	
DRAWN BY	
CHECKED BY	
APPROVED BY	
DATE	



"FOR OFFICIAL USE ONLY"

2 3 4 5 6 7



KEY MAP OF SHEETS



**LEGEND**

- |                |     |
|----------------|-----|
| ROAD           | ... |
| RAILROAD       | ... |
| UNIMPAVED ROAD | ... |
| WATER          | ... |
| ...            | ... |
| ...            | ... |

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SHEET ADDRESS	
NO.	
DATE	
BY	
FOR	
REMARKS	


NOI/0620

**MASTER SHORE STATION DEVELOPMENT PLAN**

**MAP 10 - SECTION 2**

**GENERAL DEVELOPMENT PLAN**

"FOR OFFICIAL USE ONLY"

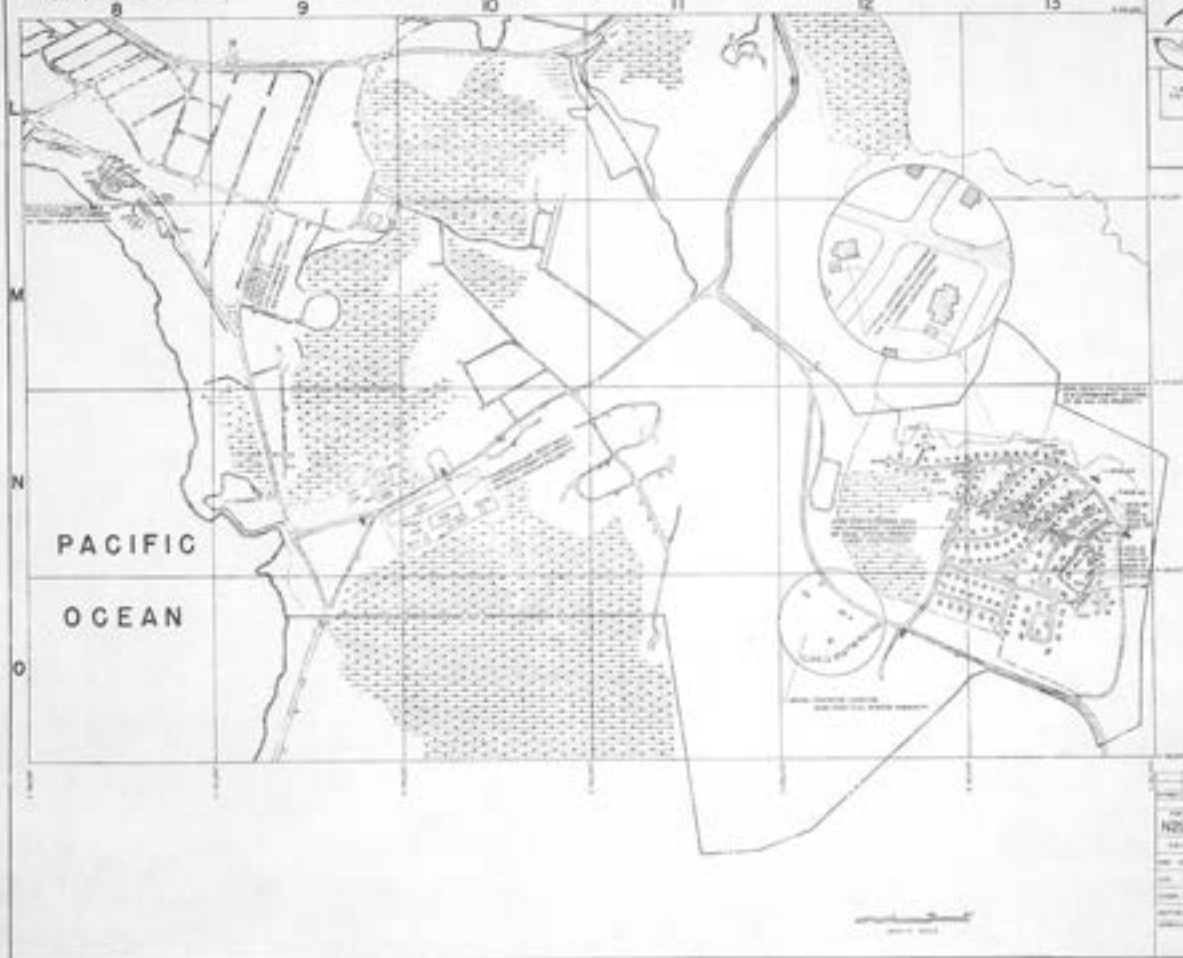

KEY MAP OF SHEETS



"FOR OFFICIAL USE ONLY"

LEGEND

EXISTING BUILDINGS	(Symbol)
NEW BUILDINGS	(Symbol)
EXISTING DRIVEWAYS	(Symbol)
NEW DRIVEWAYS	(Symbol)
EXISTING PARKING	(Symbol)
NEW PARKING	(Symbol)
EXISTING ROADS	(Symbol)
NEW ROADS	(Symbol)
EXISTING UTILITIES	(Symbol)
NEW UTILITIES	(Symbol)
EXISTING LANDSCAPE	(Symbol)
NEW LANDSCAPE	(Symbol)
EXISTING VEGETATION	(Symbol)
NEW VEGETATION	(Symbol)
EXISTING WATER	(Symbol)
NEW WATER	(Symbol)
EXISTING UTILITIES	(Symbol)
NEW UTILITIES	(Symbol)
EXISTING LANDSCAPE	(Symbol)
NEW LANDSCAPE	(Symbol)
EXISTING VEGETATION	(Symbol)
NEW VEGETATION	(Symbol)
EXISTING WATER	(Symbol)
NEW WATER	(Symbol)

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PROJECT NO.	ND/0630	DATE	NOV 1963
PROJECT NAME	PUBLIC WORKS DIVISION - BUREAU OF PUBLIC WORKS MASTER SHORE STATION DEVELOPMENT PLAN PART II - SECTION 2 GENERAL DEVELOPMENT PLAN		
DESIGNED BY	U.S. ARMY CORPS OF ENGINEERS WATERWAYS EXPERIMENTAL STATION CORVALLIS, OREGON		
APPROVED BY	[Signature]		
DATE	NOV 1963		
SCALE	AS SHOWN		
PROJECT LOCATION	[Location]		
PROJECT NO.	ND/0630		
DATE	NOV 1963		

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KEY MAP OF SHEETS



LEGEND

ROADS	ROADS
RAILROADS	RAILROADS
WATER	WATER
LAND	LAND
...	...

"FOR OFFICIAL USE ONLY"

DATE	
BY	
...	...

PROJECT NO.	121/0031
PROJECT NAME	MASTERSHORE STATION DEVELOPMENT PLAN
PROJECT LOCATION	BARBADOS
PROJECT OWNER	...
PROJECT ENGINEER	...
PROJECT ARCHITECT	...
PROJECT CONSULTANT	...
PROJECT DATE	...
PROJECT SCALE	...
PROJECT SHEET	PART II - SECTION 2
PROJECT TOTAL SHEETS	...
PROJECT TOTAL SHEETS	...
PROJECT TOTAL SHEETS	...
PROJECT TOTAL SHEETS	...
PROJECT TOTAL SHEETS	...

"FOR OFFICIAL USE ONLY"



KEY MAP OF SHEETS



COMPASS ROSE


LEGEND

EXISTING BUILDINGS	(Symbol)
EXISTING ROADS	(Symbol)
EXISTING WATERWAYS	(Symbol)
EXISTING UTILITIES	(Symbol)
EXISTING LAND USE	(Symbol)
EXISTING VEGETATION	(Symbol)
EXISTING TOPOGRAPHY	(Symbol)
EXISTING SHORELINE	(Symbol)
EXISTING MARSHES	(Symbol)
EXISTING SAND BEACHES	(Symbol)
EXISTING ROCK SHORES	(Symbol)
EXISTING CORALS	(Symbol)

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PROJECT NO.	100-1000
DATE	1962
SCALE	1:50,000
GENERAL DEVELOPMENT PLAN	
PART II - SECTION 2	
MASTER SHORE STATION DEVELOPMENT PLAN	
PUBLIC WORKS CENTER, MANAGAA	
N2/0032	

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KEY MAP OF SHEETS

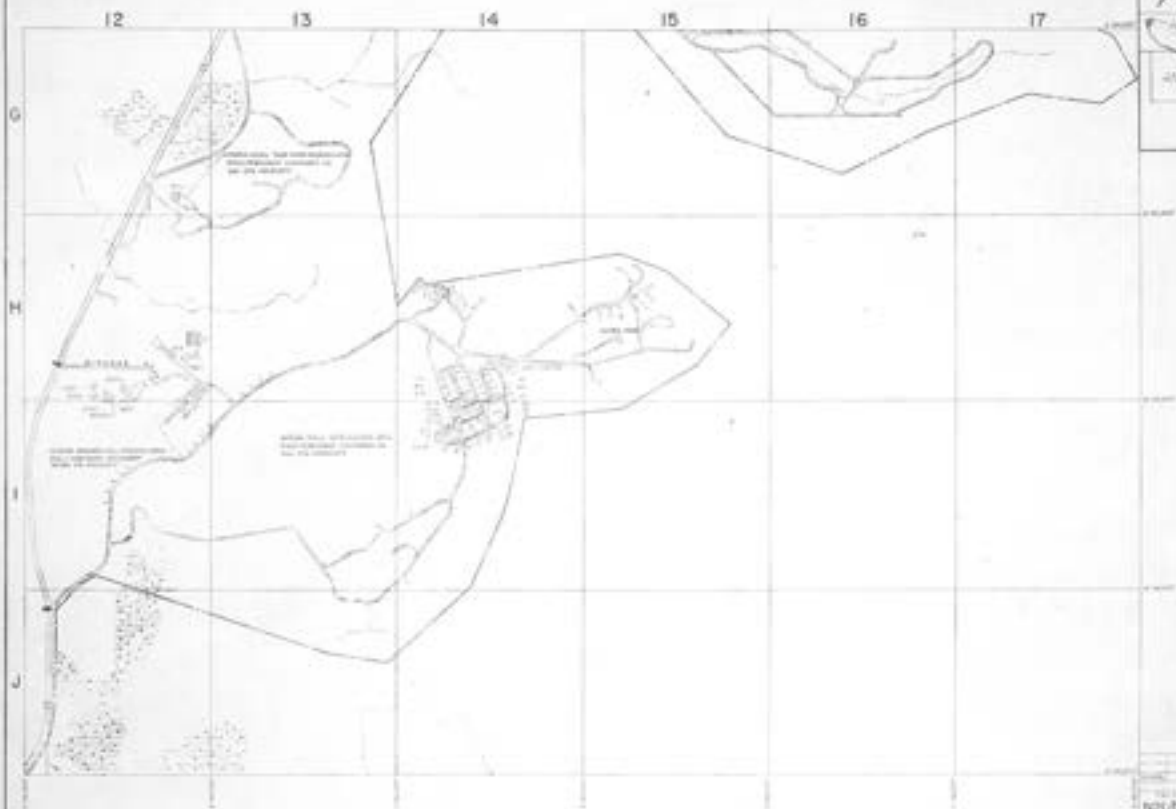

Compass rose showing North

LEGEND

- 1.00' Contour Interval
- 2.00' Contour Interval
- 3.00' Contour Interval
- 4.00' Contour Interval
- 5.00' Contour Interval
- 6.00' Contour Interval
- 7.00' Contour Interval
- 8.00' Contour Interval
- 9.00' Contour Interval
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- 97.00' Contour Interval
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- 99.00' Contour Interval
- 100.00' Contour Interval

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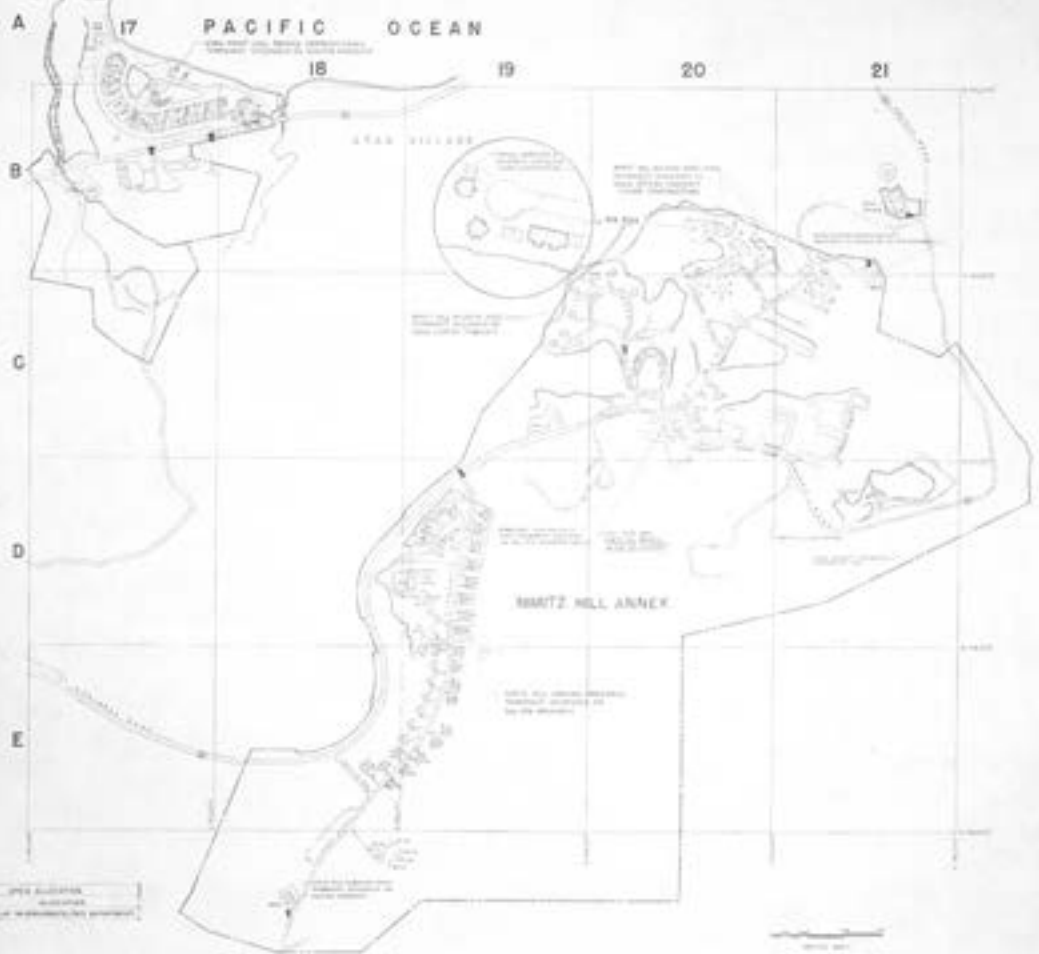
NOI/D633

U.S. ARMY CORPS OF ENGINEERS  
 PUBLIC WORKS CENTER  
**MASTER SHORE STATION  
 DEVELOPMENT PLAN**  
 PART II - SECTION 2  
**GENERAL DEVELOPMENT PLAN**

DATE: 10/10/63  
 DRAWN BY: [Name]  
 CHECKED BY: [Name]  
 APPROVED BY: [Name]



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KEY MAP OF SHEETS



"Scale is as shown on the map"

LEGEND

<ul style="list-style-type: none"> <li>  WATER AREA           </li> <li>  PAVED ROAD           </li> <li>  GRAVEL ROAD           </li> <li>  DIRT ROAD           </li> <li>  UTILITY LINE           </li> <li>  BOUNDARY           </li> <li>  AREA TO BE IMPROVED           </li> <li>  AREA TO BE DEVELOPED           </li> <li>  AREA TO BE RESERVED           </li> <li>  AREA TO BE CLEARED           </li> <li>  AREA TO BE PLANTED           </li> <li>  AREA TO BE FENCED           </li> <li>  AREA TO BE LANDSCAPED           </li> <li>  AREA TO BE MOWED           </li> <li>  AREA TO BE PAINTED           </li> <li>  AREA TO BE REPAIRED           </li> <li>  AREA TO BE REPLACED           </li> <li>  AREA TO BE REMOVED           </li> </ul>	<ul style="list-style-type: none"> <li>  WATER AREA           </li> <li>  PAVED ROAD           </li> <li>  GRAVEL ROAD           </li> <li>  DIRT ROAD           </li> <li>  UTILITY LINE           </li> <li>  BOUNDARY           </li> <li>  AREA TO BE IMPROVED           </li> <li>  AREA TO BE DEVELOPED           </li> <li>  AREA TO BE RESERVED           </li> <li>  AREA TO BE CLEARED           </li> <li>  AREA TO BE PLANTED           </li> <li>  AREA TO BE FENCED           </li> <li>  AREA TO BE LANDSCAPED           </li> <li>  AREA TO BE MOWED           </li> <li>  AREA TO BE PAINTED           </li> <li>  AREA TO BE REPAIRED           </li> <li>  AREA TO BE REPLACED           </li> <li>  AREA TO BE REMOVED           </li> </ul>
--	--

"FOR OFFICIAL USE ONLY"

DATE: 12/15/04  
 BY: [Signature]  
 FOR: [Signature]

PROJECT NO.	12/0654
PROJECT NAME	MASTER SHORE STATION DEVELOPMENT PLAN
PROJECT LOCATION	SHORE STATION, GREAT VILLAGE, BARTZ HILL ANNEX
PROJECT OWNER	U.S. NAVY
PROJECT MANAGER	[Name]
PROJECT ENGINEER	[Name]
PROJECT ARCHITECT	[Name]
PROJECT CONTRACTOR	[Name]
PROJECT COST	[Amount]
PROJECT STATUS	[Status]
PROJECT DATE	12/15/04
PROJECT SCALE	1" = 100'
PROJECT SHEET	1 OF 1
PROJECT DRAWN BY	[Name]
PROJECT CHECKED BY	[Name]
PROJECT APPROVED BY	[Name]
PROJECT TITLE	GENERAL DEVELOPMENT PLAN





**PLANNED PROJECTS**

- CENTRAL ISLAND WIDE POWER SYSTEM IMPROVEMENTS AND EXPANSION

**LEGEND**

- 115 KV TRANSMISSION LINE
- 69 KV TRANSMISSION LINE
- 33 KV TRANSMISSION LINE
- 15 KV TRANSMISSION LINE
- 6 KV TRANSMISSION LINE
- 3 KV TRANSMISSION LINE
- TELEPHONE LINE
- WATER MAIN

**REFERENCE**

- Y10 086 NO. 101 FOR GENERAL DEVELOPMENT PLAN APPROVED FEBRUARY 19 1970
- Y10 086 NO. 102 FOR FACILITIES REQUIRED BY 1970
- Y10 086 NO. 103 FOR FACILITIES AS OF 30 JUNE 1968

PROJECT NO.	Y10 086 NO. 101
PROJECT TITLE	MANILA BAY AREA DEVELOPMENT PROJECT
PROJECT NO.	NL/4895
PROJECT TITLE	PUBLIC WORKS CENTER, MANILA
PROJECT NO.	Y10 086 NO. 101
PROJECT TITLE	MASTER SHORE STATION DEVELOPMENT PLAN
PROJECT NO.	Y10 086 NO. 102
PROJECT TITLE	PART II - SECTION 2 GENERAL DEVELOPMENT PLAN POWER SYSTEM
PROJECT NO.	Y10 086 NO. 103
PROJECT TITLE	IMPROVEMENTS AS OF 30 JUNE 1968
PROJECT NO.	Y10 086 NO. 103
PROJECT TITLE	IMPROVEMENTS AS OF 30 JUNE 1968

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"FOR OFFICIAL USE ONLY"

LEGEND

- STATION 10
- STATION 11
- STATION 12
- STATION 13
- STATION 14
- STATION 15
- STATION 16
- STATION 17
- STATION 18
- STATION 19
- STATION 20
- STATION 1
- STATION 2
- STATION 3
- STATION 4
- STATION 5
- STATION 6
- STATION 7
- STATION 8
- STATION 9

NS/169	MASTER SHORE STATION DEVELOPMENT PLAN
GENERAL DEVELOPMENT PLAN	TELEPHONE SYSTEM
PART II - SECTION 2 DEVELOPMENT OF THE SHORE STATION TELEPHONE SYSTEM	
DATE: 11/15/68 DRAWN BY: [Name] CHECKED BY: [Name]	

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"FOR OFFICIAL USE ONLY"

**LEGEND**

- |                     |       |
|---------------------|-------|
| PROPOSED NEW ROAD   | ————— |
| EXISTING ROAD       | ————— |
| RAILROAD            | ————— |
| SEWERAGE SYSTEM     | ————— |
| WATER SUPPLY SYSTEM | ————— |
| PAVED ROAD          | ————— |
| UNPAVED ROAD        | ————— |
| RAILROAD            | ————— |
| PAVED ROAD          | ————— |
| UNPAVED ROAD        | ————— |
| RAILROAD            | ————— |

<b>NOV/0276 PUBLIC DEVELOPMENT BOARD</b> <b>MASTER SHORE STATION DEVELOPMENT PLAN</b> PART II - SECTION 2 <b>SEWERAGE SYSTEM</b> DIVISION OF PLANNING AND ZONING HONOLULU, HAWAII	
<small>         PROJECT NO. _____          SHEET NO. _____ OF _____          SCALE _____          DATE _____          DRAWN BY _____          CHECKED BY _____          APPROVED BY _____          TITLE _____       </small>	

"FOR OFFICIAL USE ONLY"



### PLANNED PROJECTS

- ROADS**  
IMPROVEMENTS TO EXISTING ROADS  
REPLACEMENT ROAD SEGMENTS - BETWEEN  
MILE MARKS 10 AND 12 AND 13 - 14.5
- BRIDGES**  
IMPROVEMENTS TO EXISTING BRIDGES  
REPLACEMENT ROAD BRIDGE, APPROXIMATE  
AT 0.5 MI. W. 13.5 MI. S. OF 10.5 MI. W. 13.5 MI. S.  
OF 10.5 MI. S. OF 10.5 MI. S.
- STATIONS**  
IMPROVEMENTS TO EXISTING STATIONS  
REPLACEMENT STATION BRIDGE, APPROXIMATE  
MILE MARK 13.5 - 14.5 AND 14.5 - 15.5  
TOTAL ROAD MEASUREMENT, STATION  
MARKS 11 - 15.5

### LEGEND

EXISTING ROAD	
EXISTING BRIDGE	
EXISTING STATION	
EXISTING BRIDGE	
EXISTING STATION	
EXISTING BRIDGE	
EXISTING STATION	
EXISTING BRIDGE	
EXISTING STATION	

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PROJECT NO.	NOV6389
DATE	11/19/63
SCALE	1" = 1 MILE
DESIGNED BY	W. J. BROWN
CHECKED BY	W. J. BROWN
APPROVED BY	W. J. BROWN
DATE	11/19/63
<b>MASTER SHORE STATION DEVELOPMENT PLAN</b> PART 11 - SECTION 2 <b>GENERAL DEVELOPMENT PLAN</b> ROADS AND BRIDGES SHEET 11 OF 11	

PERMANENT STRUCTURES				PERMANENT STRUCTURES (CONTINUED)				PERMANENT STRUCTURES (CONTINUED)				PERMANENT STRUCTURES (CONTINUED)			
NO.	DATE	DESCRIPTION	STATUS	NO.	DATE	DESCRIPTION	STATUS	NO.	DATE	DESCRIPTION	STATUS	NO.	DATE	DESCRIPTION	STATUS
<p><b>F 8 2 346 NO 702 242</b></p> <p>.....</p>				<p><b>F 8 2 346 NO 702 242 (CONTINUED)</b></p> <p>.....</p>				<p><b>F 8 2 346 NO 702 242 (CONTINUED)</b></p> <p>.....</p>				<p><b>F 8 2 346 NO 702 242 (CONTINUED)</b></p> <p>.....</p>			
<p><b>F 8 2 346 NO 702 241</b></p> <p>.....</p>				<p><b>F 8 2 346 NO 702 241 (CONTINUED)</b></p> <p>.....</p>				<p><b>F 8 2 346 NO 702 241 (CONTINUED)</b></p> <p>.....</p>				<p><b>F 8 2 346 NO 702 241 (CONTINUED)</b></p> <p>.....</p>			
<p><b>F 8 2 346 NO 702 240</b></p> <p>.....</p>				<p><b>F 8 2 346 NO 702 240 (CONTINUED)</b></p> <p>.....</p>				<p><b>F 8 2 346 NO 702 240 (CONTINUED)</b></p> <p>.....</p>				<p><b>F 8 2 346 NO 702 240 (CONTINUED)</b></p> <p>.....</p>			

NOV 05 1968

PUBLIC WORKS DIVISION - BUREAU OF PUBLIC WORKS

MASTER SHORF STATION DEVELOPMENT PLAN

PART II SECTION 2

GENERAL DEVELOPMENT PLAN

INDEX OF STRUCTURES

DATE OF ISSUE: NOV 05 1968

SCALE: AS SHOWN

BY: [Signature]

CHECKED: [Signature]

APPROVED: [Signature]

PERMANENT STRUCTURES (CONTINUED)	PERMANENT STRUCTURES UNDER CONST.	SEM PERMANENT STRUCTURES (CONTINUED)	TEMPORARY & ADVANCE BASE STRUCTURES
<p><b>F&amp;D DWG NO. 702 249</b></p> <p>DESCRIPTION: [Detailed description of structure 702 249]</p>	<p><b>F&amp;D DWG NO. 702 250</b></p> <p>DESCRIPTION: [Detailed description of structure 702 250]</p>	<p><b>F&amp;D DWG NO. 702 251</b></p> <p>DESCRIPTION: [Detailed description of structure 702 251]</p>	<p><b>F&amp;D DWG NO. 702 252</b></p> <p>DESCRIPTION: [Detailed description of structure 702 252]</p>
<p><b>F&amp;D DWG NO. 702 253</b></p> <p>DESCRIPTION: [Detailed description of structure 702 253]</p>	<p><b>F&amp;D DWG NO. 702 254</b></p> <p>DESCRIPTION: [Detailed description of structure 702 254]</p>	<p><b>F&amp;D DWG NO. 702 255</b></p> <p>DESCRIPTION: [Detailed description of structure 702 255]</p>	<p><b>F&amp;D DWG NO. 702 256</b></p> <p>DESCRIPTION: [Detailed description of structure 702 256]</p>
<p><b>F&amp;D DWG NO. 702 257</b></p> <p>DESCRIPTION: [Detailed description of structure 702 257]</p>	<p><b>F&amp;D DWG NO. 702 258</b></p> <p>DESCRIPTION: [Detailed description of structure 702 258]</p>	<p><b>F&amp;D DWG NO. 702 259</b></p> <p>DESCRIPTION: [Detailed description of structure 702 259]</p>	<p><b>F&amp;D DWG NO. 702 260</b></p> <p>DESCRIPTION: [Detailed description of structure 702 260]</p>
<p><b>F&amp;D DWG NO. 702 261</b></p> <p>DESCRIPTION: [Detailed description of structure 702 261]</p>	<p><b>F&amp;D DWG NO. 702 262</b></p> <p>DESCRIPTION: [Detailed description of structure 702 262]</p>	<p><b>F&amp;D DWG NO. 702 263</b></p> <p>DESCRIPTION: [Detailed description of structure 702 263]</p>	<p><b>F&amp;D DWG NO. 702 264</b></p> <p>DESCRIPTION: [Detailed description of structure 702 264]</p>
<p><b>F&amp;D DWG NO. 702 265</b></p> <p>DESCRIPTION: [Detailed description of structure 702 265]</p>	<p><b>F&amp;D DWG NO. 702 266</b></p> <p>DESCRIPTION: [Detailed description of structure 702 266]</p>	<p><b>F&amp;D DWG NO. 702 267</b></p> <p>DESCRIPTION: [Detailed description of structure 702 267]</p>	<p><b>F&amp;D DWG NO. 702 268</b></p> <p>DESCRIPTION: [Detailed description of structure 702 268]</p>
<p><b>F&amp;D DWG NO. 702 269</b></p> <p>DESCRIPTION: [Detailed description of structure 702 269]</p>	<p><b>F&amp;D DWG NO. 702 270</b></p> <p>DESCRIPTION: [Detailed description of structure 702 270]</p>	<p><b>F&amp;D DWG NO. 702 271</b></p> <p>DESCRIPTION: [Detailed description of structure 702 271]</p>	<p><b>F&amp;D DWG NO. 702 272</b></p> <p>DESCRIPTION: [Detailed description of structure 702 272]</p>
<p><b>F&amp;D DWG NO. 702 273</b></p> <p>DESCRIPTION: [Detailed description of structure 702 273]</p>	<p><b>F&amp;D DWG NO. 702 274</b></p> <p>DESCRIPTION: [Detailed description of structure 702 274]</p>	<p><b>F&amp;D DWG NO. 702 275</b></p> <p>DESCRIPTION: [Detailed description of structure 702 275]</p>	<p><b>F&amp;D DWG NO. 702 276</b></p> <p>DESCRIPTION: [Detailed description of structure 702 276]</p>
<p><b>F&amp;D DWG NO. 702 277</b></p> <p>DESCRIPTION: [Detailed description of structure 702 277]</p>	<p><b>F&amp;D DWG NO. 702 278</b></p> <p>DESCRIPTION: [Detailed description of structure 702 278]</p>	<p><b>F&amp;D DWG NO. 702 279</b></p> <p>DESCRIPTION: [Detailed description of structure 702 279]</p>	<p><b>F&amp;D DWG NO. 702 280</b></p> <p>DESCRIPTION: [Detailed description of structure 702 280]</p>
<p><b>F&amp;D DWG NO. 702 281</b></p> <p>DESCRIPTION: [Detailed description of structure 702 281]</p>	<p><b>F&amp;D DWG NO. 702 282</b></p> <p>DESCRIPTION: [Detailed description of structure 702 282]</p>	<p><b>F&amp;D DWG NO. 702 283</b></p> <p>DESCRIPTION: [Detailed description of structure 702 283]</p>	<p><b>F&amp;D DWG NO. 702 284</b></p> <p>DESCRIPTION: [Detailed description of structure 702 284]</p>
<p><b>F&amp;D DWG NO. 702 285</b></p> <p>DESCRIPTION: [Detailed description of structure 702 285]</p>	<p><b>F&amp;D DWG NO. 702 286</b></p> <p>DESCRIPTION: [Detailed description of structure 702 286]</p>	<p><b>F&amp;D DWG NO. 702 287</b></p> <p>DESCRIPTION: [Detailed description of structure 702 287]</p>	<p><b>F&amp;D DWG NO. 702 288</b></p> <p>DESCRIPTION: [Detailed description of structure 702 288]</p>
<p><b>F&amp;D DWG NO. 702 289</b></p> <p>DESCRIPTION: [Detailed description of structure 702 289]</p>	<p><b>F&amp;D DWG NO. 702 290</b></p> <p>DESCRIPTION: [Detailed description of structure 702 290]</p>	<p><b>F&amp;D DWG NO. 702 291</b></p> <p>DESCRIPTION: [Detailed description of structure 702 291]</p>	<p><b>F&amp;D DWG NO. 702 292</b></p> <p>DESCRIPTION: [Detailed description of structure 702 292]</p>
<p><b>F&amp;D DWG NO. 702 293</b></p> <p>DESCRIPTION: [Detailed description of structure 702 293]</p>	<p><b>F&amp;D DWG NO. 702 294</b></p> <p>DESCRIPTION: [Detailed description of structure 702 294]</p>	<p><b>F&amp;D DWG NO. 702 295</b></p> <p>DESCRIPTION: [Detailed description of structure 702 295]</p>	<p><b>F&amp;D DWG NO. 702 296</b></p> <p>DESCRIPTION: [Detailed description of structure 702 296]</p>
<p><b>F&amp;D DWG NO. 702 297</b></p> <p>DESCRIPTION: [Detailed description of structure 702 297]</p>	<p><b>F&amp;D DWG NO. 702 298</b></p> <p>DESCRIPTION: [Detailed description of structure 702 298]</p>	<p><b>F&amp;D DWG NO. 702 299</b></p> <p>DESCRIPTION: [Detailed description of structure 702 299]</p>	<p><b>F&amp;D DWG NO. 702 300</b></p> <p>DESCRIPTION: [Detailed description of structure 702 300]</p>

PROJECT NO. [ ]  
 DRAWING NO. **NDV-0630**  
 TITLE **PUBLIC WORKS DISTRICT - SHIPING**  
**MASTER SHORE STATION**  
**DEVELOPMENT PLAN**  
 PART OF SECTION 2  
**GENERAL DEVELOPMENT PLAN**  
 INDEX OF STRUCTURES  
 PREPARED BY [ ]  
 DATE [ ]

F & D	NO.	NO.	NO.
F & D	NO. 702 262		
[Detailed description of structure 702 262]			
F & D	NO. 702 263		
[Detailed description of structure 702 263]			
F & D	NO. 702 264		
[Detailed description of structure 702 264]			
F & D	NO. 702 265		
[Detailed description of structure 702 265]			
F & D	NO. 702 266		
[Detailed description of structure 702 266]			
F & D	NO. 702 267		
[Detailed description of structure 702 267]			


F & D	NO.	NO.	NO.
F & D	NO. 702 267		
[Detailed description of structure 702 267]			
F & D	NO. 702 268		
[Detailed description of structure 702 268]			
F & D	NO. 702 269		
[Detailed description of structure 702 269]			
F & D	NO. 702 270		
[Detailed description of structure 702 270]			
F & D	NO. 702 271		
[Detailed description of structure 702 271]			
F & D	NO. 702 272		
[Detailed description of structure 702 272]			

F & D	NO.	NO.	NO.
F & D	NO. 702 267		
[Detailed description of structure 702 267]			
F & D	NO. 702 268		
[Detailed description of structure 702 268]			
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[Detailed description of structure 702 269]			
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[Detailed description of structure 702 270]			
F & D	NO. 702 271		
[Detailed description of structure 702 271]			
F & D	NO. 702 272		
[Detailed description of structure 702 272]			

F & D	NO.	NO.	NO.
F & D	NO. 702 268		
[Detailed description of structure 702 268]			
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[Detailed description of structure 702 270]			
F & D	NO. 702 271		
[Detailed description of structure 702 271]			
F & D	NO. 702 272		
[Detailed description of structure 702 272]			

PROJECT NO. 8040  
 PUBLIC WORKS DISTRICT - REGIONAL  
 MASTER SHORE STATION  
 DEVELOPMENT PLAN  
 PART II SECTION 2  
 GENERAL DEVELOPMENT PLAN  
 INDEX OF STRUCTURES  
 DRAWING DATE: 12/20/84  
 DRAWN BY: [Name]  
 CHECKED BY: [Name]



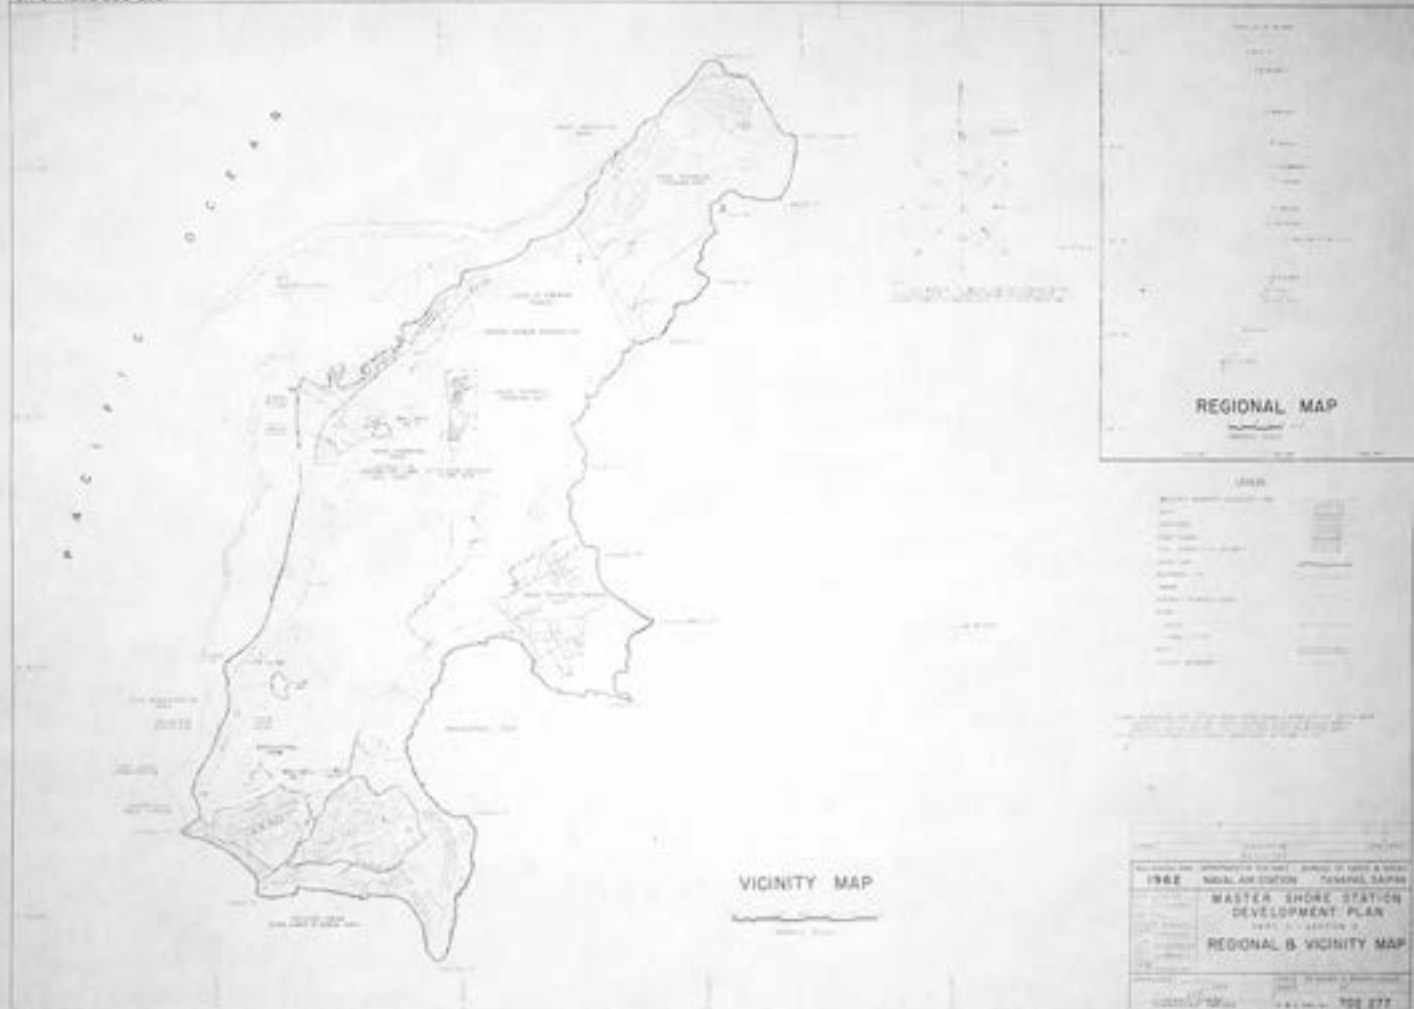



- Legend**
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  - 2. Proposed Buildings
  - 3. Existing Roads
  - 4. Proposed Roads
  - 5. Existing Utilities
  - 6. Proposed Utilities
  - 7. Existing Fences
  - 8. Proposed Fences
  - 9. Existing Vegetation
  - 10. Proposed Vegetation
  - 11. Existing Water Features
  - 12. Proposed Water Features
  - 13. Existing Airfields
  - 14. Proposed Airfields
  - 15. Existing Storage Areas
  - 16. Proposed Storage Areas
  - 17. Existing Parking Areas
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  - 19. Existing Security Perimeters
  - 20. Proposed Security Perimeters

**1955**

U.S. AIR FORCE  
 AIR FORCE ENGINEERING & DEVELOPMENT CENTER  
 WRIGHT-PATTERSON AIR FORCE BASE  
 DAYTON, OHIO

**MASTER SHORE STATION  
 DEVELOPMENT PLAN**

**GENERAL DEVELOPMENT PLAN**

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